



- NOTES:**
1. ALL DIMENSIONS & LEVELS ARE IN MM UNLESS MENTIONED OTHERWISE.
 2. ALL EXTERIOR WALLS ARE 200 MM THICK & INTERIOR WALLS 100 MM THICK.
 3. THE DRAWING SHALL BE READ, NOT SCALING FROM THE PAPER OR IN FULL.
 4. THE DRAWING SHALL BE USED FOR THE PURPOSES STATED AND SHALL NOT BE USED FOR ANY OTHER PURPOSE WITHOUT WRITTEN CONSENT FROM THE ARCHITECT.

PS Vinayak Heights LLP
 E-10, Sector 10, Gurgaon
 Haryana, India
 P. No. 11111111111
 M. No. 9876543210

CERTIFICATE OF GEO TECHNICAL ENGINEER:
 I, THE UNDERSIGNED, HAVE EXAMINED THE FOUNDATION DESIGN AND DRAWINGS FOR THE PROPOSED BUILDING AND AM Satisfied THAT THE FOUNDATION DESIGN IS SAFE AND SOUND AND THE BUILDING WILL BE STABLE AND SAFE TO OCCUPY. I HAVE ALSO CHECKED THE STRUCTURE OF THE FOUNDATION AND FOUND IT TO BE SATISFACTORY. I HAVE ALSO CHECKED THE DESIGN OF THE FOUNDATION AND FOUND IT TO BE SATISFACTORY. I HAVE ALSO CHECKED THE DESIGN OF THE FOUNDATION AND FOUND IT TO BE SATISFACTORY.

CERTIFICATE OF STRUCTURAL ENGINEER:
 I, THE UNDERSIGNED, HAVE EXAMINED THE STRUCTURAL DESIGN AND DRAWINGS FOR THE PROPOSED BUILDING AND AM Satisfied THAT THE STRUCTURAL DESIGN IS SAFE AND SOUND AND THE BUILDING WILL BE STABLE AND SAFE TO OCCUPY. I HAVE ALSO CHECKED THE DESIGN OF THE STRUCTURE AND FOUND IT TO BE SATISFACTORY. I HAVE ALSO CHECKED THE DESIGN OF THE STRUCTURE AND FOUND IT TO BE SATISFACTORY.


Signature of Architect:
 AMRIT AGARWALA
 ARCHITECT
 UPTAL SOUTH
 UPTAL SOUTH
 UPTAL SOUTH

Signature of Structural Engineer:
 ANIL AGARWALA
 STRUCTURAL ENGINEER
 UPTAL SOUTH
 UPTAL SOUTH
 UPTAL SOUTH


Signature of Geo Technical Engineer:
 JISHU PAL
 GEO TECHNICAL ENGINEER
 UPTAL SOUTH
 UPTAL SOUTH
 UPTAL SOUTH

Signature of Consultant:
 AMRIT AGARWALA
 ARCHITECT
 UPTAL SOUTH
 UPTAL SOUTH
 UPTAL SOUTH


Signature of Client:
 AMRIT AGARWALA
 ARCHITECT
 UPTAL SOUTH
 UPTAL SOUTH
 UPTAL SOUTH

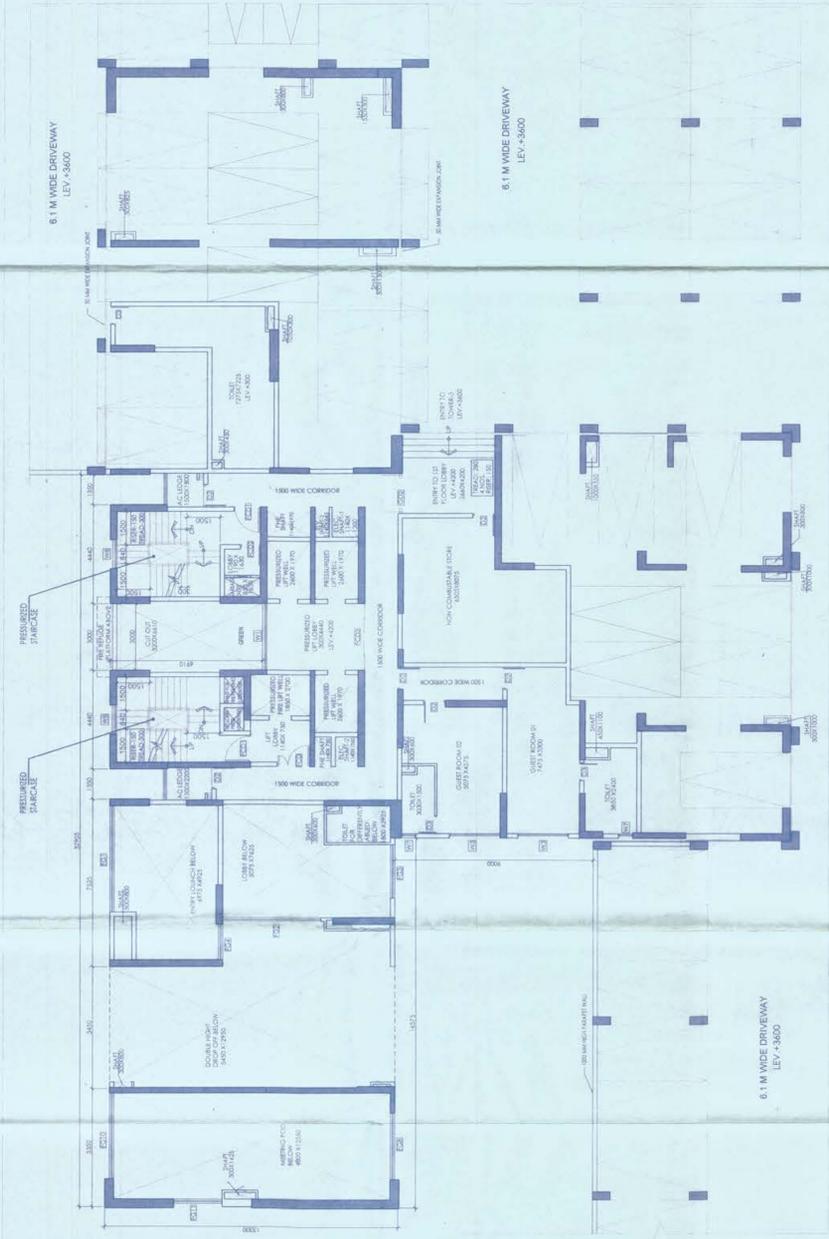


FIRST FLOOR PLAN

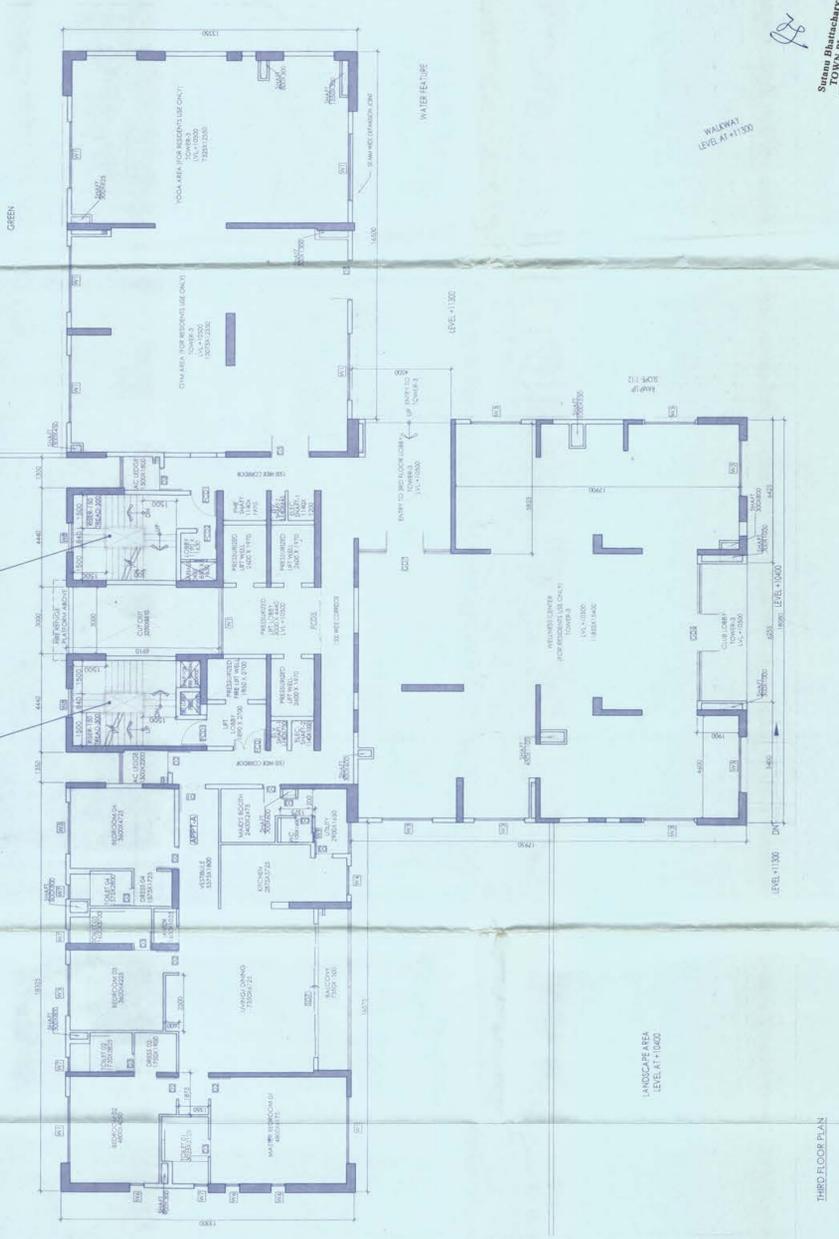

THIRD FLOOR PLAN

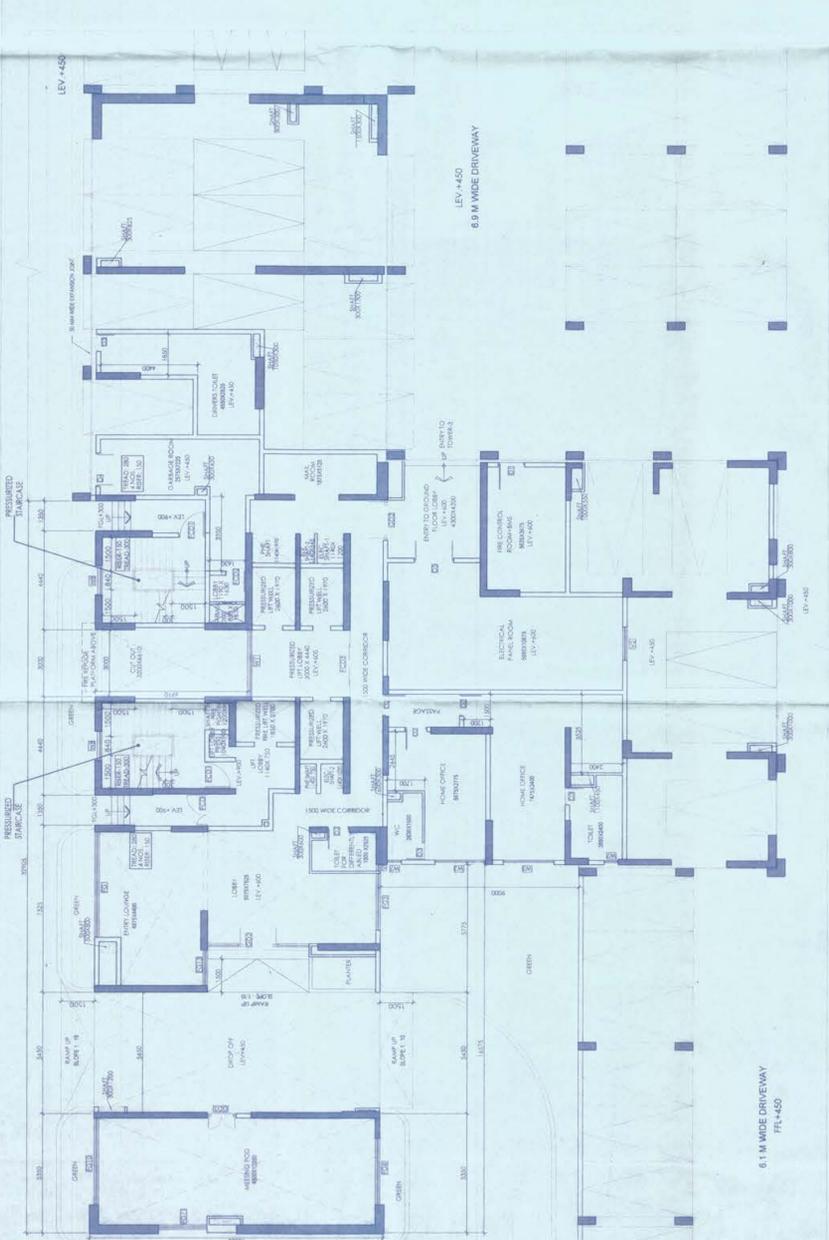

GROUND FLOOR PLAN

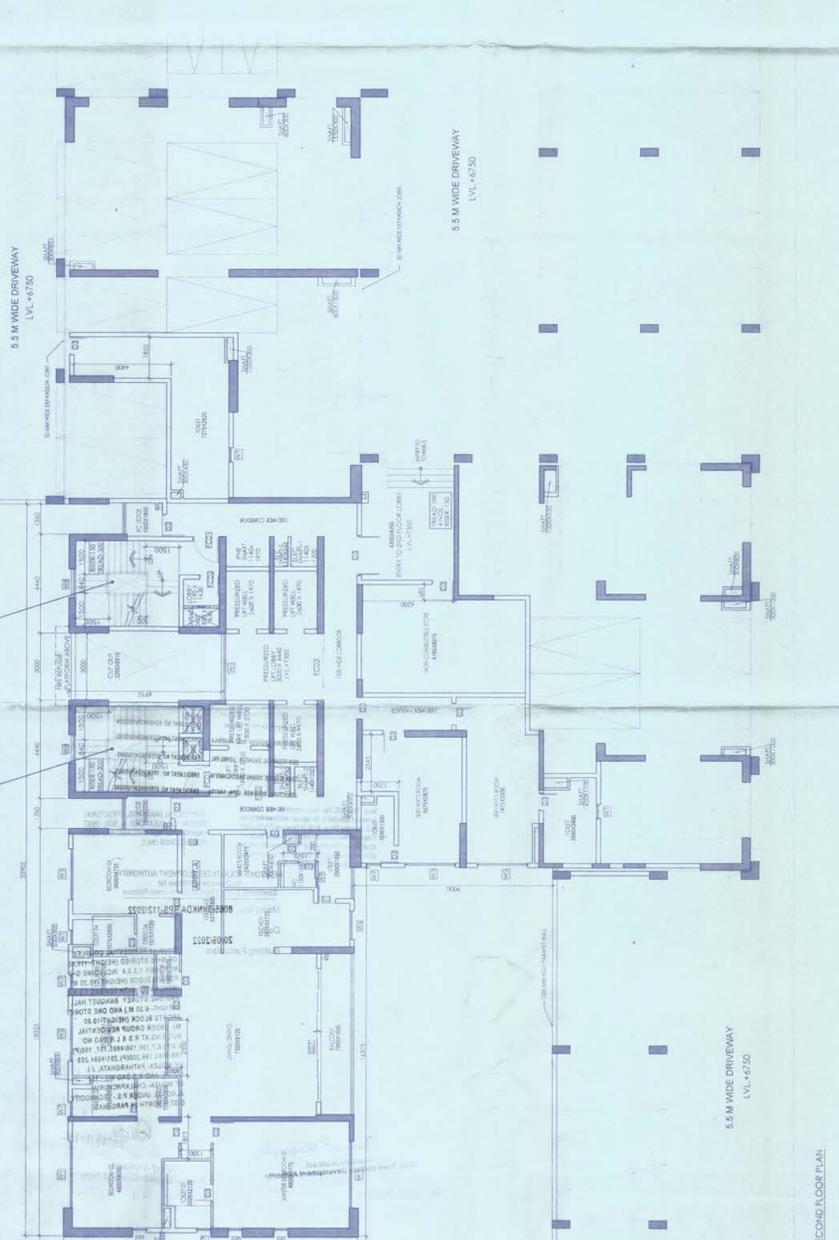

SECOND FLOOR PLAN

Project Information:
 Project Name: UPTAL SOUTH
 Location: UPTAL SOUTH
 Client: AMRIT AGARWALA
 Architect: AMRIT AGARWALA
 Structural Engineer: ANIL AGARWALA
 Geo Technical Engineer: JISHU PAL
 Consultant: AMRIT AGARWALA
 Date: 2022/11/10
 Scale: 1:100
 Drawing No: VNA-SD-10
 Job No: 2022/11/10